

#### NOTES:

R30 MIN, BARRIER-BACKED INSULATION IN ROOF

GROUT ALL CELLS. WALL REINFORCING STEEL SIZE AND SPACING PER CONTRACTOR SUPPLIED CIVIL OR STRUCTURAL ENGINEER STAMPED PLANS.

> 5", 3,500 PSI, PCC SLAB WITH #3 REBAR @ 24"x24" REINFORCEMENT.

2"x6" STEEL STUD FRAMING R30 INSULATION, GREENBOARD GYPSUM AND WATERPROOF PAINT AND TEXTURE.

RAIN GUTTER

METAL SIDING & PURLIN-

FOR REDUCED PLANS 0
ORIGINAL SCALE IS IN INCHES L

ATTACHMENT TO PURLIN

DESIGNED BY LICENSED STRUCTURAL ENGINEER

IGID STEEL FRAME

FOOTINGS PER CONTRACTOR SUPPLIED, CIVIL OR-

**CMU WALL DETAIL** 

SCALF: NTS

- SEE SHELTER DRAINAGE PLAN FOR SLOPES AND DRAINAGE OF DOG KENNELS AS WELL AS KENNEL GUILLOTINE DOOR OPENING DETAIL.
- OUTSIDE AND INSIDE COLORS OF BUILDING TO BE DETERMINED NEAR THE CONCLUSION OF CONSTRUCTION BY THE ANIMAL SHELTER MANAGER.

- CAT CAGE SIZES AS SHOWN. CAT CAGES TO BE STACKABLE MASON CO STAINLESS STEEL CAT CONDOS OR APPROVED EQUAL. TOTAL CAGES ARE DOUBLE WHAT IS SHOWN ON PLAN.
- 2. INSIDE DOG KENNELS TO BE MASON CO STAINLESS STEEL SANIKENNEL PANELS WITH STAINLESS STEEL CAGES WITH SANI—SLOPE "I" FLOOR SEAL AND SANI SEAL, CHAIN LINK TOP AND GATES OR APPROVED EQUAL. OUTSIDE UNITS TO BE MASON CO CHAIN LINK TOP AND GATES WITH GALVANIZED ISOLATION PANELS. 22 OUTSIDE UNITS, 48"x52" AND 20 INSIDE UNITS, 48"x96". 2 INSIDE UNITS 40"x96".

JAHLSTROM

Project Enginee

JTATUM

#### DOOR SCHEDULE

- (D1) 3'-0" x 6'-8" INTERIOR (NON-RATED)
- (D2) 3'-0" x 6'-8" INTERIOR WITH 2'x2' WINDOW (NON-RATED)
- D3 3'-0" x 6'-8" EXTERIOR METAL DOOR 20 GA. LIGHT COMMERCIAL DUTY, HOLLOW METAL TYPE WITH METAL JAMBS, SMOKE SALS, INSULATED, WITH 2'x2' WINDOW AND INTERNAL RI IND SYSTEM
- (D4) 3'-0" x 6'-8" EXTERIOR METAL DOOR 20 GA. LIGHT COMMERCIAL DUTY, HOLLOW METAL TYPE WITH METAL JAMBS, INSULATED.
- D5) 3'-0" x 6-0" CHAIN LINK GATE.


# WINDOW SCHEDULE


- (W1) 48" x 48" DOUBLE PAINED SINGLE SLIDER
- (W2) 48" x 12" DOUBLE PAINED SINGLE SLIDER PRIVACY FROSTED
- (W3) 48" x 12" DOUBLE PAINED SINGLE SLIDER
- W4 72" x 12" DOUBLE PAINED CASEMENT WINDOW WITH OPENING RODS
- W5 72" x 48" SHATTERPROOF, INTERIOR VIEWING WINDOW.

#### **BUILDING NOTES**

- BUILDING SHALL CONFORM TO TITLE 24 NON-RESIDENTIAL ENERGY STANDARDS. CONTRACTOR SHALL SUBMIT SIGNED AND STAMPED COMPLIANCE PLANS AND DOCUMENTS PRIOR TO CONSTRUCTION.
- 2. BUILDING SHALL CONFORM TO THE CALIFORNIA BUILDING CODE, MOST RECENT EDITION, AS WELL AS THE MOST RECENT EDITION OF THE ADA REGULATIONS.
- 3. RESTROOM SHALL CONFORM TO ADA REGULATIONS.
- 4. ALL INTERIOR WALLS SHALL BE 1 HOUR FIRE RATED.
- FLOORING IN RESTROOM AND OFFICE SHALL BE ARMSTRONG BIOBASED TILE OR APPROVED EQUAL.
- ALL DOORS SHALL HAVE DOOR CLOSERS COMPLIANT WITH ADA AND CBC REGULATIONS. ALL DOORS SHALL HAVE HARDWARE CONFORMING TO ADA REGULATIONS.
- 7. ALL WINDOWS TO HAVE REMOVABLE SCREENS.
- 8. ALL ROOMS NOT LOCATED IN THE DOG KENNEL AREA SHALL HAVE TEXTURED WALLS AND CEILINGS. WALLS AND CEILINGS TO BE TAPED, TEXTURED AND PAINTED WITH WATER PROOF, EPOXY BASED PAINTS. ALL FLOORS NOT COVERED WITH VCT FLOORING SHALL BE COVERED WITH EPOXY BASED, WATERPROOF SEALANT. ALL COLORS TO BE DETERMINED BY THE ANIMAL SHELTER MANAGER.
- CMU WALL AREAS IN KENNELS SHALL BE COVERED IN WATERPROOF, EPOXY BASED SEALANT. 2 COATS.
- 10. CONTRACTOR SHALL SUBMIT DATASHEETS FOR ALL PRODUCTS USED.
- 11. ALL VCT FLOORING AREAS AS WELL AS THE MOST EASTERLY WALL OF THE KENNEL ROOM SHALL HAVE 4" HIGH RUBBERIZED BASE (COVE FACE) INCLUDED AS PART OF THE FLOORING INSTALLATION.
- 12. CONTRACTOR TO SUPPLY CIVIL OR STRUCTURAL ENGINEER STAMPED AND SIGNED PLANS FOR BUILDING AND CMU CONNECTION POINT TO METAL BUILDING. SEE PROPOSED DETAIL HEREON.
- CEILING IN OFFICE, EXAM ROOM, CAT ROOM, RESTROOM, DOG ROOM AND WAITING AREAS TO BE DROP TYPE 8' FROM FINISHED FLOOR ELEVATION.
- 14. CMU WALLS SHALL BE SOLID GROUTED, HAVE DEEPENED FOOTINGS AND REINFORCING STEEL PER CONTRACTOR SUPPLIED CIVIL OR STRUCTURAL ENGINEER STAMPED AND SIGNED PLANS.

Plans Prepared by: COUNTY OF INYO INYO COUNTY ANIMAL SHELTER PROJECT PUBLIC WORKS 1001 COUNTY ROAD, BIG PINE, CA 168 N. Edwards, P.O. Drawer Q Independence, CA 93526 FLOOR PLAN (760) 878-0201 5/12/14 Designed by Drawing Name: SHEET 5 OF 9 MAY 2014 JJEROPKIN MAY 2014 ANIMAL SHELTER 2013.dwg **JJEROPKIN** 

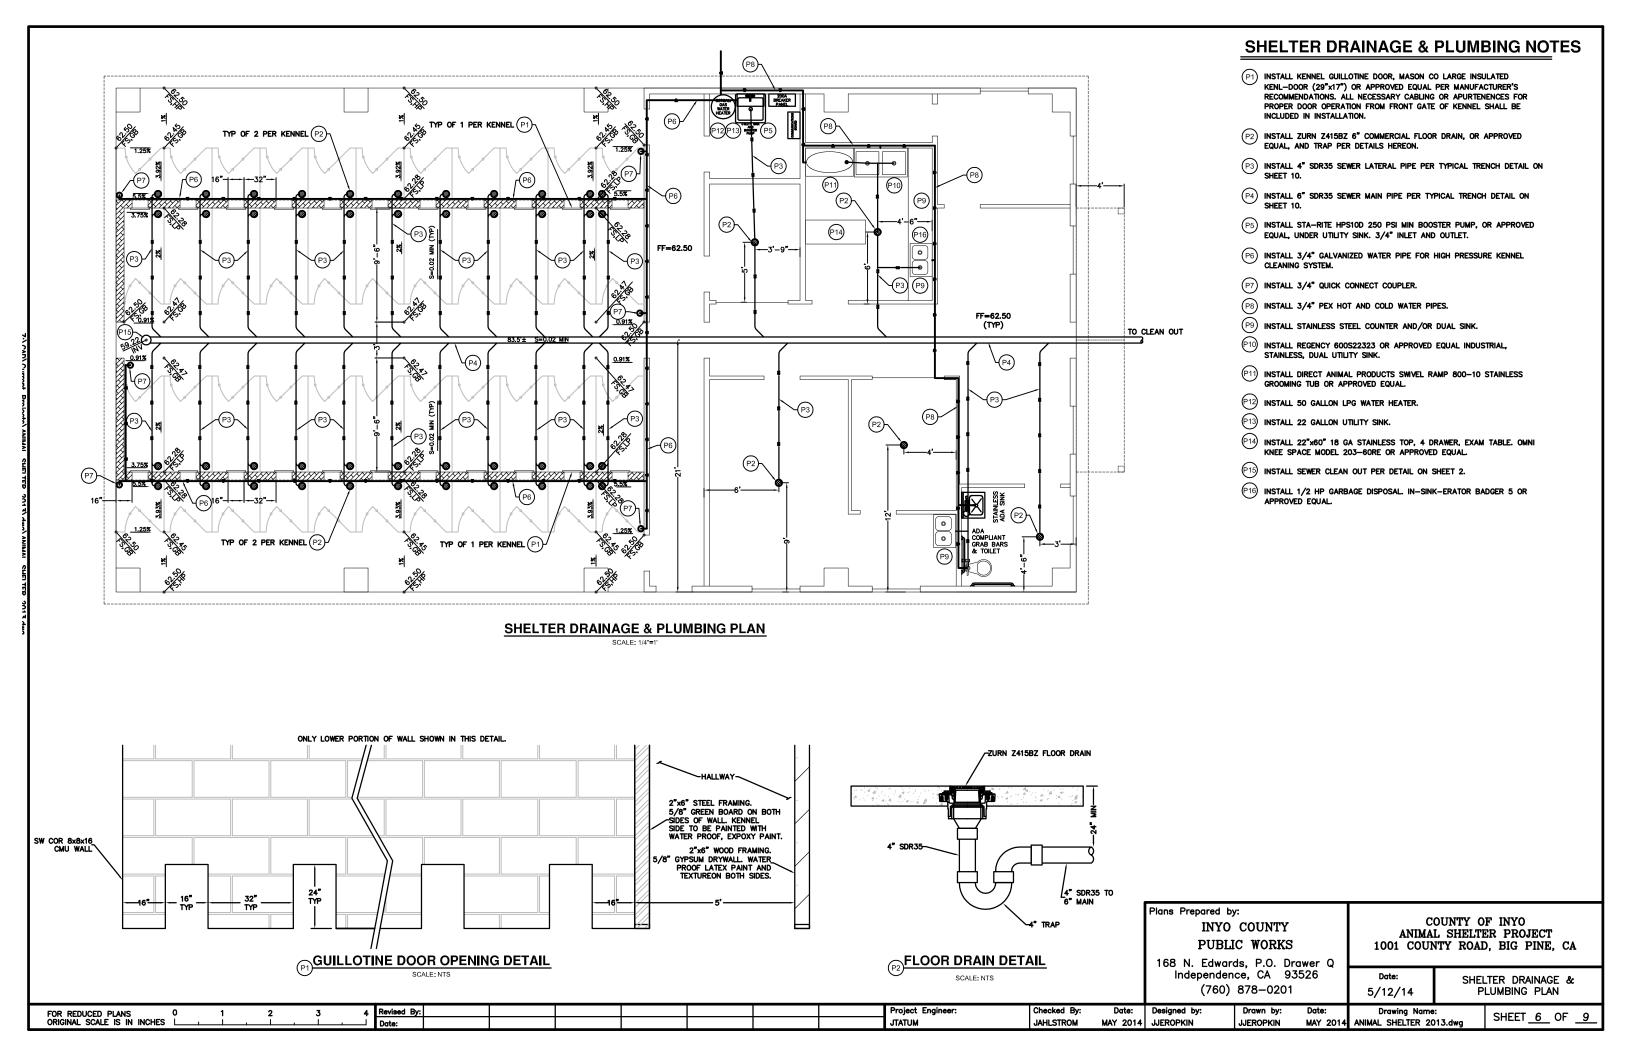

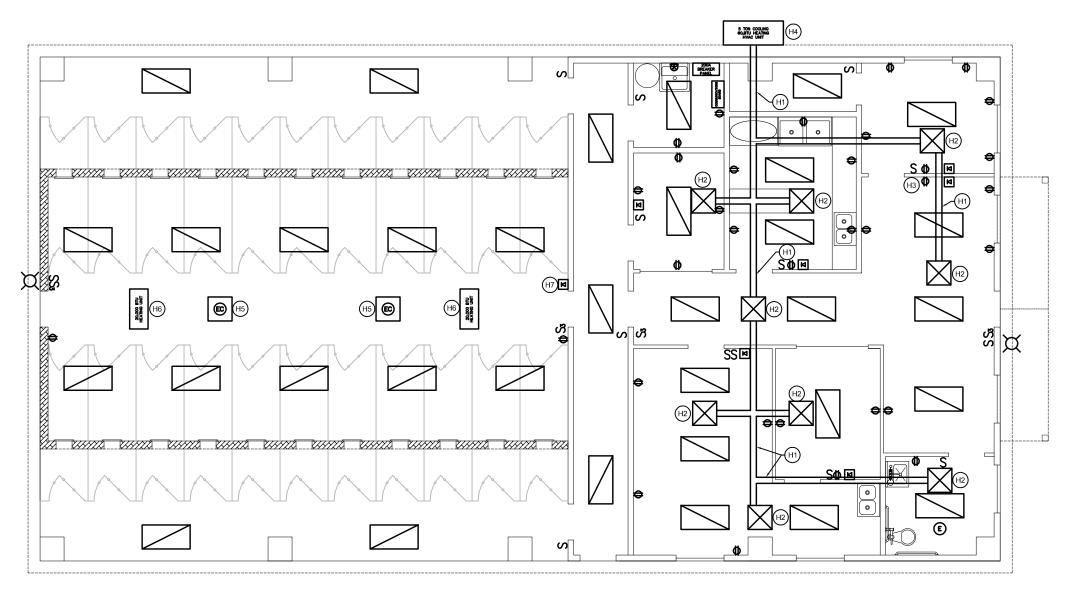

## **ELECTRICAL & HVAC PLAN**

SCALE: 1/4"=1'

- NOTES:

  1. LOCATIONS OF OUTLETS, LIGHTS, SWITCHES, DATA JACKS, AND VENTS ARE APPROXIMATE. FINAL LOCATIONS TO BE DETERMINED BY THE ENGINEER AND/OR ANIMAL SHELTER STAFF.
- 2. ALL RECEPTACLES LOCATED IN KENNEL AREA TO HAVE GFI PROTECTION AND TO BE HOUSED WITH WATERPROOF COVERS.

## **ELECTRICAL & HVAC LEGEND**

2' x 4' FLOURESCENT LIGHT FIXTURE

RESTROOM EXHAUST FAN

3-WAY SWITCH

SINGLE SWITCH

20A, 120V, RECEPTACLE OUTLET

60A, 220V, SINGLE PHASE RECEPTACLE OUTLET

X

EXTERIOR LIGHT

M 200A BREAKER PANEL

PHONE & DATA JACK 200A BREAKER PANEL



COMMUNICATIONS BOARD



ROOF MOUNT, 3,000 CFM, 1/3 HP, EVAPORATIVE COOLER

5 TON COOLING 80,8TU HEATING HVAC UNIT

HVAC UNIT



CEILING MOUNT HEATING UNIT, 20,000 BTU



HVAC VENT

## **HVAC NOTES**

- (H1) INSTALL INSULATED AND FLEXIBLE DUCTING. CONTRACTOR SHALL DETERMINE ALL DUCT SIZES, LOCATIONS AND ATTACHMENTS FOR ALL HEATING AND COOLING DUCTWORK (BASED ON EQUIPMENT AIR FLOWS) AND SHALL SUBMIT LAYOUT SKETCHES AND CUT SHEETS TO COUNTY ENGINEER FOR APPROVAL PRIOR TO INSTALLATION. ALL WORK SHALL BE INSTALL PER APPLICABLE BUILDING CODE REQUIREMENTS.
- H2 INSTALL CEILING MOUNT VENT. CONTRACTOR SHALL DETERMINE SIZES, TYPES, AND ROOM LOCATIONS FOR CEILING MOUNT SUPPLY AND RETURN VENTS AND DUCTWORK AND SHALL SUBMIT LAYOUT SKETCHES AND CUT SHEETS TO COUNTY ENGINEER FOR APPROVAL PRIOR TO INSTALLATION.
- (H3) INSTALL OFFICE THERMOSTAT.
- $\stackrel{\rm (H4)}{}$  install 5 ton cooling, 60,000 btu heating hvac unit, carrier 48VL—a performance series or approved equal.
- H5 INSTALL ROOF MOUNT, 3,000 CFM, 1/3 HP EVAPORATIVE COOLER AND
- (H6) INSTALL 20,000 BTU CEILING MOUNT HEATING UNIT. XXX OR APPROVED EQUAL.
- (H7) INSTALL KENNEL COOLER AND HEATER CONTROLLERS AND THERMOSTAT.

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COUNTY OF INYO ANIMAL SHELTER PROJECT 1001 COUNTY ROAD, BIG PINE, CA

168 N. Edwards, P.O. Drawer Q Independence, CA 93526 (760) 878-0201

5/12/14

ELECTRICAL & HVAC PLAN

FOR REDUCED PLANS 0
ORIGINAL SCALE IS IN INCHES L

Project Engineer JTATUM

JAHLSTROM


MAY 2014 JJEROPKIN


Designed by:

JJEROPKIN

Drawing Name: MAY 2014 ANIMAL SHELTER 2013.dwg

SHEET 7 OF 9

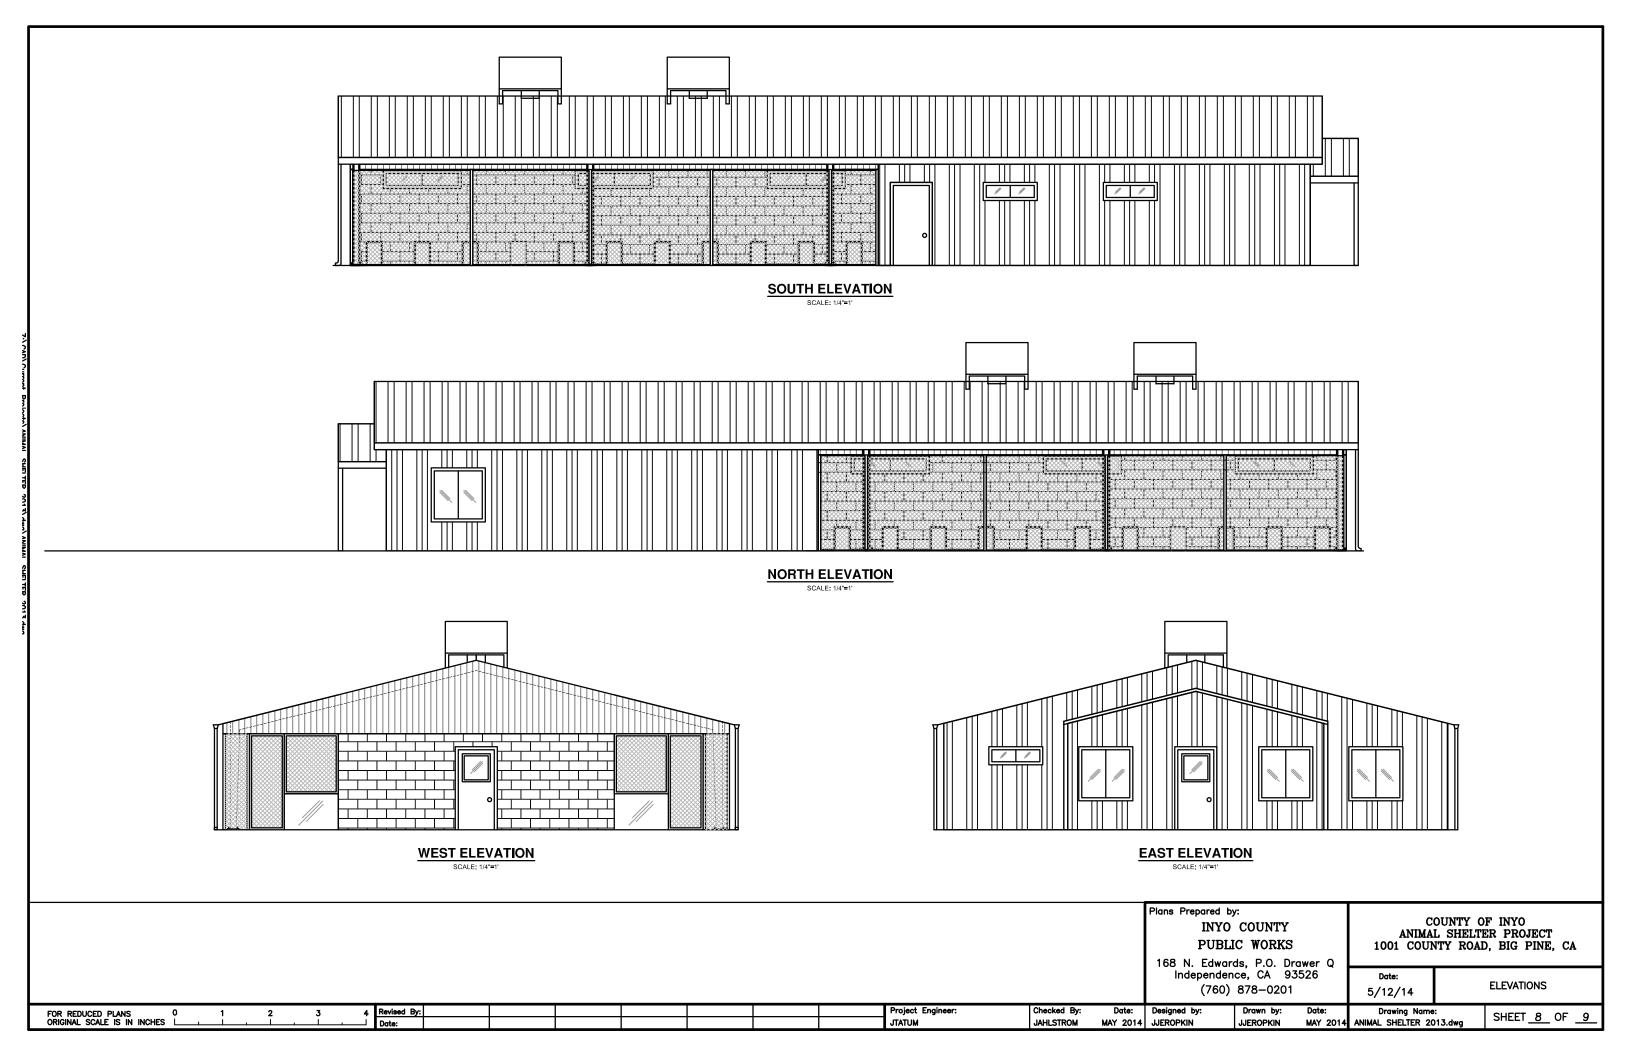

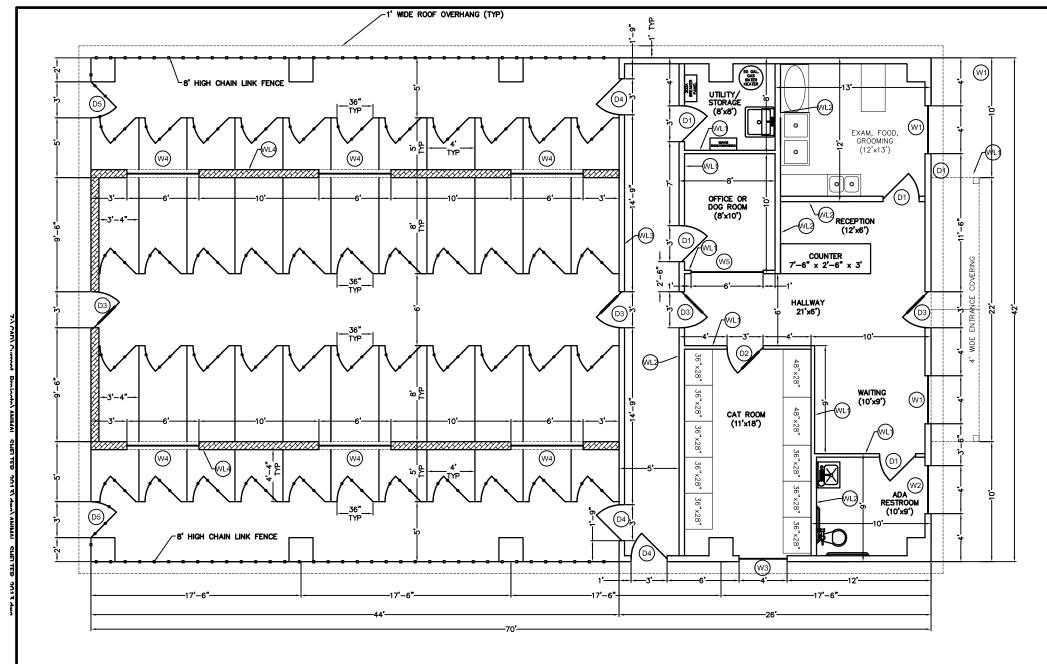

#### ANIMAL SHELTER DEDUCTIVE BID ITEM FLOOR PLAN

FOR REDUCED PLANS 0
ORIGINAL SCALE IS IN INCHES L

## WALL SCHEDULE

- (VL) 2"x4" WOOD STUD FRAMING
- (VL) 2"x6" WOOD STUD FRAMING
- (VL3) 2"x6" STEEL STUD FRAMING
- 8' TALL 8"x8"x16" CMU WALL WITH 2"x6" STEEL STUD FRAMING TO ROOF.

## **DOOR SCHEDULE**

- $\bigcirc$ 1) 3'-0" × 6'-8" INTERIOR (NON-RATED)
- (D2) 3'-0" x 6'-8" INTERIOR WITH 2'x2' WINDOW (NON-RATED)
- 3'-0" x 6'-8" EXTERIOR METAL DOOR 20 GA. LIGHT COMMERCIAL DUTY, HOLLOW METAL TYPE WITH METAL JAMBS, SMOKE SEALS, INSULATED, WITH 2'x2' WINDOW AND INTERNAL BLIND SYSTEM
- $\Box 4$  3'-0" x 6'-8" exterior metal door 20 ga. Light commercial duty, hollow metal type with metal jambs, INSULATED.
- (D5) 3'-0" x 6-0" CHAIN LINK GATE.
- (D6) 32" INTERIOR CLOSET DOOR (NON-RATED)

## **WINDOW SCHEDULE**

- (W1) 48" x 48" DOUBLE PAINED SINGLE SLIDER
- (W2) 48" x 12" DOUBLE PAINED SINGLE SLIDER PRIVACY FROSTED
- (W3) 48" x 12" DOUBLE PAINED SINGLE SLIDER
- W4) 72" x 12" DOUBLE PAINED CASEMENT WINDOW WITH OPENING RODS
- W5 72" x 48" SHATTERPROOF, INTERIOR

## **BUILDING NOTES**

- ALL BUILDING AND ANIMAL CAGE NOTES ON SHEET 5 APPLY TO THIS SHEET AS WELL AS THE CMU WALL DETAIL.
- PLUMBING, ELECTRICAL, HYAC AND SHELTER DRAINAGE PLANS WILL BE SIMILAR TO SHEET 5. THE COUNTY WILL FURNISH THESE PLANS IF DEDUCTIVE BID ITEM IS CHOSEN AS THE AWARDED BID.

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COUNTY OF INYO ANIMAL SHELTER PROJECT 1001 COUNTY ROAD, BIG PINE, CA

168 N. Edwards, P.O. Drawer Q Independence, CA 93526 (760) 878-0201

DEDUCTIVE BID ITEM FLOOR PLAN 5/12/14

Project Engineer Designed by: Drawing Name: SHEET 9 OF 9 JTATUM MAY 2014 ANIMAL SHELTER 2013.dwg JAHLSTROM MAY 2014 JJEROPKIN JJEROPKIN